# GAME DAY MEN'S HEALTH SUITE 102

BAPTIST WESTOVER HILLS 3903 WISEMAN BLVD. SAN ANTONIO, TEXAS 78251



[ADDDOVAL -

CICNIATUDE

[REVISIONS -

GAME DAY MEN'S HEALTH
BAPTIST WESTOVER HILLS

1,891 RSF TEXAS ACCESSIBILITY STANDARDS, ELIMINATION OF ARCHITECTURAL BARRIERS, TEXAS GOVERNMENT CODE, INTERIOR DESIGNER GENERAL NOTES/INSTRUCTIONS CHAPTER 469 ADMINISTERED BY THE TEXAS DEPARTMENT OF LICENSING AND REGULATION SHALL CONDUCT A PLAN REVIEW TO VERIFY ALL CONSTRUCTION DOCUMENTS COMPLY WITH THE REGULATIONS AS WE UNDERSTAND THEM. IF GAME DAY MEN'S HEALTH ada standards THE JORDAN GROUP DEMO FLOOR PLAN/NEW FLOOR PLAN/LIFE SAFETY/FINISHES ANY PLAN DISCREPANCIES SHALL ARISE, INTERIOR DESIGNER WILL ADDRESS WITH OWNER UPON PLAN REVIEW 250 E BASSE RD #208, 20079 STONE OAK PKWY., STE 1200 POWER/ RCP ELEVATIONS/SECTIONS SAN ANTONIO, TX 78209 SAN ANTONIO, TX 78258 A FIELD INSPECTION SHALL ALSO TAKE PLACE AFTER CERTIFICATE OF SUBSTANTIAL COMPLETION HAS BEEN ISSUED TO PHONE: 210-900-3691 PHONE: 210-267-8320 ENSURE ALL CONSTRUCTION IS IN COMPLIANCE WITH TEXAS JACCESSIBILITY STANDARDS (TAS). THE SCOPE OF OUR SERVICES IS LIMITED TO THE INTERIOR FINISH OUT ONLY. EXISTING BUILDING CONDITIONS MAY ALSO BE INSPECTED CONTACT: VERNIE LIEB CONTACT: RUTH JORDAN & KATY MCKENNA AND ANY NON-COMPLIANT CONDITIONS OUTSIDE OF OUR SCOPE OF SERVICES SHALL BE REMEDIED AT THE EMAIL: VERNIE.LIEB@GMAIL.COM RUTH@THEJORDANGROUP-SA.COM ANY NEW CONSTRUCTION FOUND TO BE NON-COMPLIANT AND DOES NOT REFLECT OUR CONSTRUCTION KATY@THEJORDANGROUP-SA.COM DOCUMENTS WILL BE THE RESPONSIBILITY OF THE CONTRACTOR AND SHALL BE CORRECTED AS REQUIRED. CODE INFORMATION Building / Dwelling Code IBC 2021 with local amendments Structural Code IBC 2021 with local amendments 1. IN LIEU OF EXISTING BLINDS TO REMAIN, PROVIDE AND INSTALL NEW ROLLER SHADES BY SWF CONTRACT, 5% OPENNESS, COLOR TBS, INSIDE MOUNT/VALANCE TO MATCH STANDARD BUILDING FRAME, COLOR: CLEAR Plumbing Code IPC 2021 with local amendments Mechanical Code IMC 2021 with local amendments 2. IN LIEU OF EXISTING MILLWORK TO BE REMOVED, NEW MILLWORK TO MACH GAME DAY STANDARD COLORS, PROJECT SUMMARY Electrical Code NEC 2020 with local amendments REMOVE EXISTING PLUMBING. PRICE AS ALTERNATE # 2. Fire/Life Safety Code IFC 2021 with local amendments Accessibility Code State of Texas Accessibility Standards (TAS) USABLE AREA: 1,891 RSF SPRINKLED: YES BUILDING TYPE: IIB Energy Code IECC 2021 with local amendments NUMBER OF EXITS REQUIRED: 1 OCCUPANCY TYPE: B OCCUPANT LOAD (PER IBC 2021): WAITING = 10 TOTAL OCCUPANTS = 20

PRICING —

THESE DRAWINGS ARE ISSUED AS PRICING DOCUMENTS ONLY NOT FOR CONSTRUCTION.
RUTH JORDAN TEXAS REGISTRATION #10682

PROJECT INFORMATION——

DRAWN BY: KM
REVIEW: 10/18/2024
PRICING:

CONSTRUCTION:

[ DRAWING TITLE: —

TITLE PAGE

SHEET NO.

AO.

SHEET 1 OF 6

ABOVE FINISHED FLOOR

ACOUSTICAL CEILING TILE

ADDITION or ADDENDUM

CONSTRUCTION DOCUMENTS

AIR CONDITIONING

**ACOUSTIC** 

MALUMINUM

**ALTERNATE** 

**AVERAGE** 

BOARD

BLOCK

BEAM

BUILDING

BLOCKING

**CLEAN OUT** 

CABINET

**CEMENT** 

CERAMIC

**CHANNEI** 

CEILING

**CLOSET** 

CLEAR

**CAULKING** 

**CENTERED** 

COLUMN

CONCRETE

COMBINATION

CONSTRUCTION

CONTINUOUS

DISHWASHER

DEMOLITION

DIAMETER

DIAGONAL

DIMENSION

EXHAUST FAN

ELEVATION

**ELEVATOR** 

**EQUIPMENT** 

**ESTIMATE** 

**EXHAUST** 

**EXTERIOR** 

FIRE ALARM

EXISTING

SECURE CONTINUOUS METAL

TRACK TO STRUCTURE

CEILING AS SPEC'D.

3-5/8" METAL STUDS -

5/8" TYPE 'X' G.W.B.

25 GAUGE @ 16" O.C. MAX

SECURE CONTINUOUS METAL

TRACK TO STRUCTURE

BASE AS SPEC'D

3-1/2" SOUND BATT. INSULATION

**EQUAL** 

**EXPANSION JOINT** 

"ELECTRIC, ELECTRICAL"

DOWN

DOOR

E.F.

EA.

ELEV.

EQUIP.

EXIST. or E

EQ.

EST.

EXH.

EXT.

F.A.

**DOUBLE** 

CONTRACTOR

DRINKING FOUNTAIN

**CENTERLINE** 

**CERAMIC TILE** 

**CONTROL JOINT** 

**CIRCUIT BREAKER** 

CONCRETE MASONRY UNIT

**BOTTOM OF** 

F.D.

F.E.

F.O.

F.S.

FIN.

GFI

GL

H.M.

H/C

HTR

INT.

L.FT.

LAT.

LD.

LIN.

NO.

NOM.

O.C.

O.D.

O.H.

NUMBER

NOMINAL

ON CENTER

OVER HANG

**OUTSIDE DIAMETER** 

FACP

FLOOR DRAIN

FACE OF

FLOOR SINK

FIRE EXTINGUISHER

FIRE ALARM CONTROL PANEL

#### GENERAL CONTRACTOR NOTES & INSTRUCTIONS

- 1. GENERAL CONDITIONS: "GENERAL CONDITIONS OF THE CONTRACT FOR CONSTRUCTION" AIA DOCUMENT - A201, SHALL GOVERN ALL WORK PERFORMED UNDER THIS CONTRACT.
- 2. ALL REQUEST FOR CLARIFICATIONS OF THESE DRAWINGS SHALL BE SUBMITTED IN WRITING TO THE DESIGNER.
- 3. CLAIMS FOR ADDITIONAL COSTS: ALL ADDITIONAL CLAIMS TO THE CONTRACT SUM SHALL BE ISSUED IN WRITING WITHIN 7 DAYS AFTER EVENT WHICH CAUSES SUCH CLAIM. THIS NOTICE SHALL BE GIVEN BY THE CONTRACTOR BEFORE PROCEEDING TO EXECUTE THE WORK, EXCEPT IN EMERGENCIES ENDANGERING LIFE OR PROPERTY IN WHICH CASE THE CONTRACTOR SHALL PROCEED IN ACCORDANCE WITH GENERAL INSTRUCTION.
- 4. ANY CHANGE TO CONTRACT SUM SHALL BE AUTHORIZED BY A WRITTEN CHANGE ORDER ONLY.
- 5. NO SUBSTITUTIONS SHALL BE MADE UNLESS SUBMITTED TO THE DESIGNER IN WRITING WITHIN 5 DAYS OF CONTRACT AWARD. EACH REQUEST SHALL INCLUDE DESCRIPTION OF PROPOSED SUBSTITUTE, NAME OF MATERIAL OR EQUIPMENT FOR WHICH IT IS TO REPLACE, AS WELL AS CUT SHEETS, SPECIFICATIONS, OR PERTINENT DATA NECESSARY TO MAKE AN INFORMED EVALUATION. INTERIOR DESIGNER SHALL APPROVE/ DENY EACH REQUEST IN WRITING.
- 6. A DIRECTORY OF ALL SUBCONTRACTORS SHALL BE PROVIDED TO INTERIOR DESIGNER WITHIN 5 DAYS OF AWARD OF CONTRACT
- 7. WITHIN 5 DAYS OF CONTRACT AWARD, CONTRACTOR SHALL CERTIFY THAT ALL MATERIALS AND EQUIPMENT NECESSARY FOR THE COMPLETION OF PROJECT ARE ORDERED AND DELIVERY DATES ARE COORDINATED WITH PROJECT SCHEDULE. ANY EXCEPTIONS SHALL BE BROUGHT FORTH AT THIS TIME ALONG WITH REQUESTS FOR SUBSTITUTIONS.
- 8. PROGRESS SCHEDULE: CONTRACTOR SHALL PROVIDE AN ESTIMATED PROGRESS SCHEDULE TO INTERIOR DESIGNER FOR REVIEW WITHIN 5 DAYS OF AWARDED CONTRACT.
- 9. PROTECTION- PERSONS AND PROPERTY: CONTRACTOR SHALL TAKE ALL REASONABLE PRE-CAUTIONS FOR THE SECURITY AND PROTECTION OF EMPLOYEES AND ALL PERSONS WHO MAY BE AFFECTED ON THE JOB IN ORDER TO PREVENT DAMAGE, INJURY, OR LOSS. ALL COMPLETED WORK MATERIALS, AND EQUIPMENT TO BE INCORPORATED THEREIN WHICH IS IN THE CARE, CUSTODY, OR CONTROL OF THE CONTRACTOR, AND ALL OTHER PROPERTY AT THE SITE OR ADJACENT THERETO.
- 10. CONTRACTOR SHALL COMPLY WITH ALL APPLICABLE LAWS, ORDINANCES, AND REGULATIONS, OF ANY PUBLIC AUTHORITY HAVING JURISDICTION. IN THE EVENT OF AN EMERGENCY AFFECTING SAFETY OF PERSONS OR PROPERTY, THE CONTRACTOR SHALL WORK TO PREVENT THREATENED DAMAGE, INJURY, OR LOSS.
- 11. CONTRACTOR SHALL ENFORCE DISCIPLINE AND GOOD ORDER AMONG CONTRACTORS, SUBCONTRACTORS, AND ALL ORGANIZED TRADES AND NOT PERMIT ANY UNLICENSED OR UNQUALIFIED PERSONS TO CARRY OUT THE WORK ASSIGNED TO THEM.
- 12. CONTRACTOR SHALL FIELD VERIFY ALL EXISTING CONDITIONS AND DIMENSIONS PRIOR TO COMMENCEMENT OF WORK AND SHALL NOTIFY ALL PROJECT TEAM MEMBERS OF ANY DISCREPANCIES.
- 13. ALL CONSTRUCTION SHALL COMPLY WITH MOST CURRENT ADOPTED EDITION OF BUILDING AND LOCAL CODES.
- 14. MECHANICAL, ELECTRICAL AND PLUMBING SYSTEMS SHALL COMPLY WITH ALL APPLICABLE CITY AND STATE ORDINANCES.
- 15. CONTRACTOR IS RESPONSIBLE FOR IMPLEMENTING SAFETY GUIDELINES AND NECESSARY PRE-CAUTIONS FOR THE SECURITY AND PROTECTION OF EMPLOYEES AND ALL OTHER PERSONS WHO MAY BE AFFECTED IN ORDER TO PREVENT DAMAGE, INJURY OR LOSS.
- 16. COMPLETION: UPON COMPLETION OF WORK, CONTRACTOR AND OWNER TO PREPARE A PUNCH LIST OR WRITTEN DOCUMENT SPECIFYING ALL AREAS OF WORK THAT STILL NEED ATTENTION. PROJECT WILL NOT BE DEEMED COMPLETE UNTIL ALL OUTSTANDING ITEMS ARE COMPLETED AND APPROVED BY OWNER/ TENANT.
- 17. ALL AFTER HOURS WORK SHALL BE SCHEDULED/ COORDINATED WITH BUILDING OWNER.

- 18. GENERAL CONTRACTORS SHALL NOT ALLOW ANY DEBRIS TO ACCUMULA STRUCTURE OR ON GROUNDS, HAUL AWAY AND DISPOSE OF AT CONTRA EXPENSE. UPON JOB COMPLETION, ALL GLASS SURFACES SHALL BE CLEAR WORK AREA LEFT "BROOM CLEAN."
- 19. ACCOMMODATIONS SHALL BE MADE TO PROTECT PORTIONS OF THE BUIL IDENTIFIED AS NOT IN CONTRACT: DO NOT ALLOW LEAKS IN EXISTING STRU AND ELIMINATE OR CONTROL ALL SMOKE/ DUST.
- 20. ALL EXITS ARE TO BE OPERATIVE FROM INSIDE OF SPACE WITHOUT KEY OR KNOWLEDGE OR EFFORT.
- 21. CONTRACTOR RESPONSIBLE FOR IDENTIFYING EXISTING BUILDING SLAB A CONDITIONS PRIOR TO ANY CORE DRILLING OF CUTTING. X-RAYS OF SLAI BE REQUIRED DEPENDING ON BUILDING TYPE, PRIOR TO ANY CUTTING. X-BE REVIEWED BY ENGINEER. COORDINATE WITH OWNER LOCATION AND OF STRUCTURAL MEMBERS AND REINFORCING, AS WELL AS OTHER BUILDI SYSTEMS THAT MAY BE AFFECTED BY CUTTING OPERATION. ANY REPAIRS RESULTING IN FAILURE TO DO SO WILL BE RESPONSIBILITY OF CONTRACTO ITS SUBCONTRACTORS.
- 22. BY EXECUTING THE CONTRACT, THE CONTRACTOR REPRESENTS THAT HE VISITED THE SITE. FAMILIARIZED HIMSELF WITH LOCAL OBLIGATIONS UNDER THE WORK IS TO BE PERFORMED, AND REFERENCED HIS FINDINGS WITH TH CONTRACT DOCUMENTS. ANY DISCREPANCIES, ERRORS, OR OMISSIONS IMMEDIATELY BE REPORTED TO THE INTERIOR DESIGNER.
- 23. MECHANICAL, ELECTRICAL, PLUMBING, SPRINKLER SYSTEMS AND FIRE SAF SHALL BE AS ENGINEERED BY BUILDING CONSULTING ENGINEER OR GENE CONTRACTORS / SUBCONTRACTOR IN ACCORDANCE WITH ALL APPLICA BUILDING CODES.
- 24. ALL WORK IS SUBJECT TO APPROVAL BY INTERIOR DESIGNER.
- 25. GENERAL CONTRACTOR TO PROVIDE AND INSTALL ALL FIRE EXTINGUISHE FIRE EXTINGUISHER CABINETS IN QUANTITIES AND LOCATIONS REQUIRED E
- 26. MECHANICAL ELECTRICAL, PLUMBING, FIRE AND SAFETY SYSTEMS SHALL E ENGINEERED BY BUILDING CONSULTING ENGINEER OR GENERAL CONTRA SUBCONTRACTOR IN ACCORDANCE WITH ALL APPLICABLE BUILDING CC CONTRACTOR TO COORDINATE LOCATIONS OF ALL FIRE ALARM DEVICES AND THERMOSTATS WITH DESIGNER PRIOR TO ROUGH-IN AND INSTALLATION.
- 27. PROVIDE ALL SAFETY SYSTEMS AS REQUIRED FOR NEW WALL CONFIGURATIONS. PROVIDE ALL REQUIRED EXIT SIGNS, EMERGENCY LIGHTS, FIRE EXTINGUISHERS, SMOKE DETECTORS, AND FIRE ALARMS TO MEP ALL APPLICABLE CODES. ALL SYSTEMS TO BE TIED INTO BUILDING SYSTEMS AS REQUIRED. RELOCATE SPRINKLER HEADS AS REQUIRED DUE TO NEW WALL AND LIGHTING CONFIGURATIONS IN ACCORDANCE WITH APPLICABLE CODES. EMERGENCY LIGHTING IS TO BE VIA BATTERY PACK ONLY.
- 28. MODIFY OR PROVIDE NEW HVAC SYSTEM AS REQUIRED DUE TO NEW WALL CONFIGURATIONS AND LIGHTING CONFIGURATIONS.
- 29. PROVIDE INDEPENDENT TEST AND BALANCE OF THE HVAC SYSTEM AFTER CONSTRUCTION IS COMPLETE.
- 30. THE GENERAL CONTRACTOR IS RESPONSIBLE FOR DETERMINING THE SCOPE OF DEMOLITION.
- 31. CONTRACTOR IS RESPONSIBLE FOR OBTAINING ALL REQUIRED BUILDING. CONSTRUCTION AND INSPECTION PERMITS AND FEES PRIOR TO THE START OF CONSTRUCTION.
- 32. G.C. TO COORDINATE WITH BUILDING OWNER/MANAGEMENT FOR ALARM PROTOCOL IN REGARDS TO ANY SCOPE OF WORK THAT COULD CAUSE FIRE ALARMS TO ACTIVATE.
- 33. G.C. TO NOTIFY DESIGNER OF ANY DISCREPANCIES WITH ADA STANDARDS PER
- 34. STARTING CONSTRUCTION PRIOR TO OBTAINING PERMIT IS AT GENERAL CONTRACTOR'S OWN RISK.
- FIRE AND SAFETY NOTES:

FIRE SPRINKLER HEADS: RECESSED ESCUTCHEONS W/ CONCEALED CAP

FIRE SYSTEM STROBE/ SOUNDERS: TO MATCH EXISTING SYSTEM

ATE IN ACTOR'S NED AND	A.F.F. A/C ABV.
	ACOU. ACT ADD.
ILDING PUCTURE	AL. or ALU ALT. AVG
R SPECIAL	B.O. BD. BLDG BLK.
ND AB MAY (-RAY TO EXTENT ING	BLKG. BM. C.D. C.J. C.O. C.T. CAB
OR AND	CEM. CER CH ar
HAS R WHICH HE SHALL	CKT. BKR. CL OILC CLG. CLKG. CLO. CLR. CMU
FETY ERAL :ABLE	CMU CNTRD. COL. COMB. CONC. CONST. CONT. CONTR. D.F.
ERS AND BY CODE.	D/W DBL. DEMO
BE ACTOR'S DDES.	DIA. or Ø DIAG. DIM. DN.

PERP. ar FDC FIRE DEPARTMENT CONNECTION FDN. **FOUNDATION** PLAS. FINISH PLUMB **FLOOR PLYWD FLOORING** PORC. **FLUORESCENT PREFAB** FIRE PROOF **PSF FURN FURNISH** PSI **GAUGE** PTN. GALVANIZED **GFCI** GROUND FAULT CIRCUIT INTERRUPTER **GROUND FAULT INTERRUPTER** GLASS **GYPSUM** GYP. GYP. BD. GYPSUM BOARD **HOLLOW CORE** HOLLOW METAI **HANDICAPPED** RM**HDW** HARDWARE HGT. HEIGHT S/L **HEATER** HEATING, VENTILATING & AIR CONDITION HVAC HOT WATER **IDENTIFICATION** ISOLATED GROUND **INCL** "INCLUDE, INCLUSIVE" INSUL. INSULATION INTERIOR J-BOX JUNCTION BOX LINEAR FEET STL. LAMINATE LATERAL SW LAV LAVATORY LEAD LINEAR T.V. LIGHT TEL. MAT'L MATERIAL TH. MAX. MAXIMUM **MECH** MECHANICAL MANUFACTURING MFR. MANUFACTURER TLT. MIN. MINIMUM TYP. MISC **MISCELLANEOUS** MOD MODULAR MTL. METAL MULLION NOT IN CONTRACT NOT TO SCALE N.T.S. NFC NOT FOR CONSTRUCTION

POWER QUANTITY RADIUS **ROUGH OPENING** R.O. REF REFRIGERATOR REF. REFERENCE REQ'D. REQUIRED REVISION REV. ROOM S.C. SOLID CORE SKYLIGHT STAINLESS STEEI **SELF CLOSING** SCHEDULE SECT. SECTION SHEET SIM. SPECS Similar SPECIFICATIONS SQ. FT STC SQUARE FEET SOUND TRANSMISSION CLASS STD. STANDARD STEEL SUSP. SUSPENDED SWITCH SYM SYMMETRICAL SYS. SYSTEM **TELEVISION OUTLET TELEPHONE THRESHOLD** THD. THREADED THK. THICK **THRU** THROUGH TOILET TYPICAL URINAL V.B. VAPOR BARRIER V.I.F. **VERIFY IN FIELD** VINYL COMPOSITION TILE VERT. VERTICAL WATER CLOSET W/C WINDOW WEATHER PROOF WP WT. WEIGHT W/ WITH W/O WITHOUT WD. WOOD

OH

OPNG.

OPPO.

P.LAM.

PERF.

**OVER HEAD** 

PERFORATED

PLASTIC LAMINATE

PERPENDICULAR

**OPENING** 

**OPPOSITE** 

**PLASTER** 

PLASTIC

PLUMBING

**PLYWOOD** 

**PARTITION** 


**PORCELAIN** 

PREFABRICATED

FLOOR PLAN KEYED NOTE POWER PLAN KEYED NOTE RCP KEYED NOTE **ELEVATION KEYED NOTE** ROOM NAME/ NUMBER DOOR KEY POUNDS PER SQUARE FOOT **ELEVATION KEY** POUNDS PER SQUARE INCH SECTION REFERENCE KEY

**DETAIL REFERENCE KEY** 

 $\triangleleft$ **4** ШФ  $\triangleleft$ 

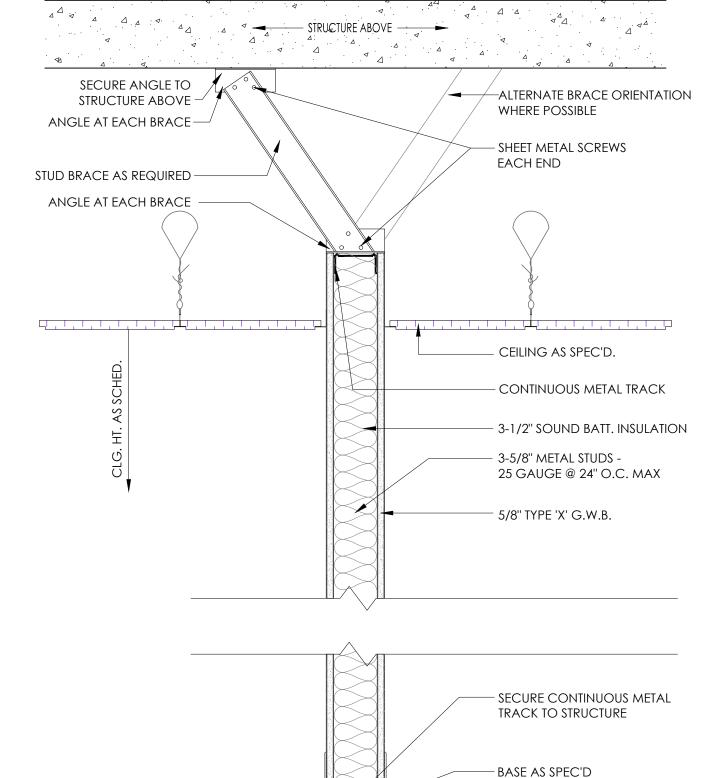

TYPICAL WALL PARTITION

SCALE: 1-1/2" = 1'-0"

20079 STONE OAK PKWY #1200

SAN ANTONIO, TEXAS 78258

**SIGNATURE** 

PRICING -THESE DRAWINGS ARE ISSUED AS PRICING DOCUMENTS ONLY NOT FOR CONSTRUCTION. RUTH JORDAN TEXAS

REGISTRATION #10682

PROJECT INFORMATION——

DRAWN BY: KM REVIEW: 10/18/2024 PRICING:


CONSTRUCTION: DRAWING TITLE: -**GENERAL NOTES** INSTRUCTIONS

**WALL SECTIONS** 

SHEET NO.

SHEET 2 OF 6

DEMISING/ FULL HEIGHT WALL PARTITION <sup>/</sup> SCALE: 1-1/2" = 1'-Ø"

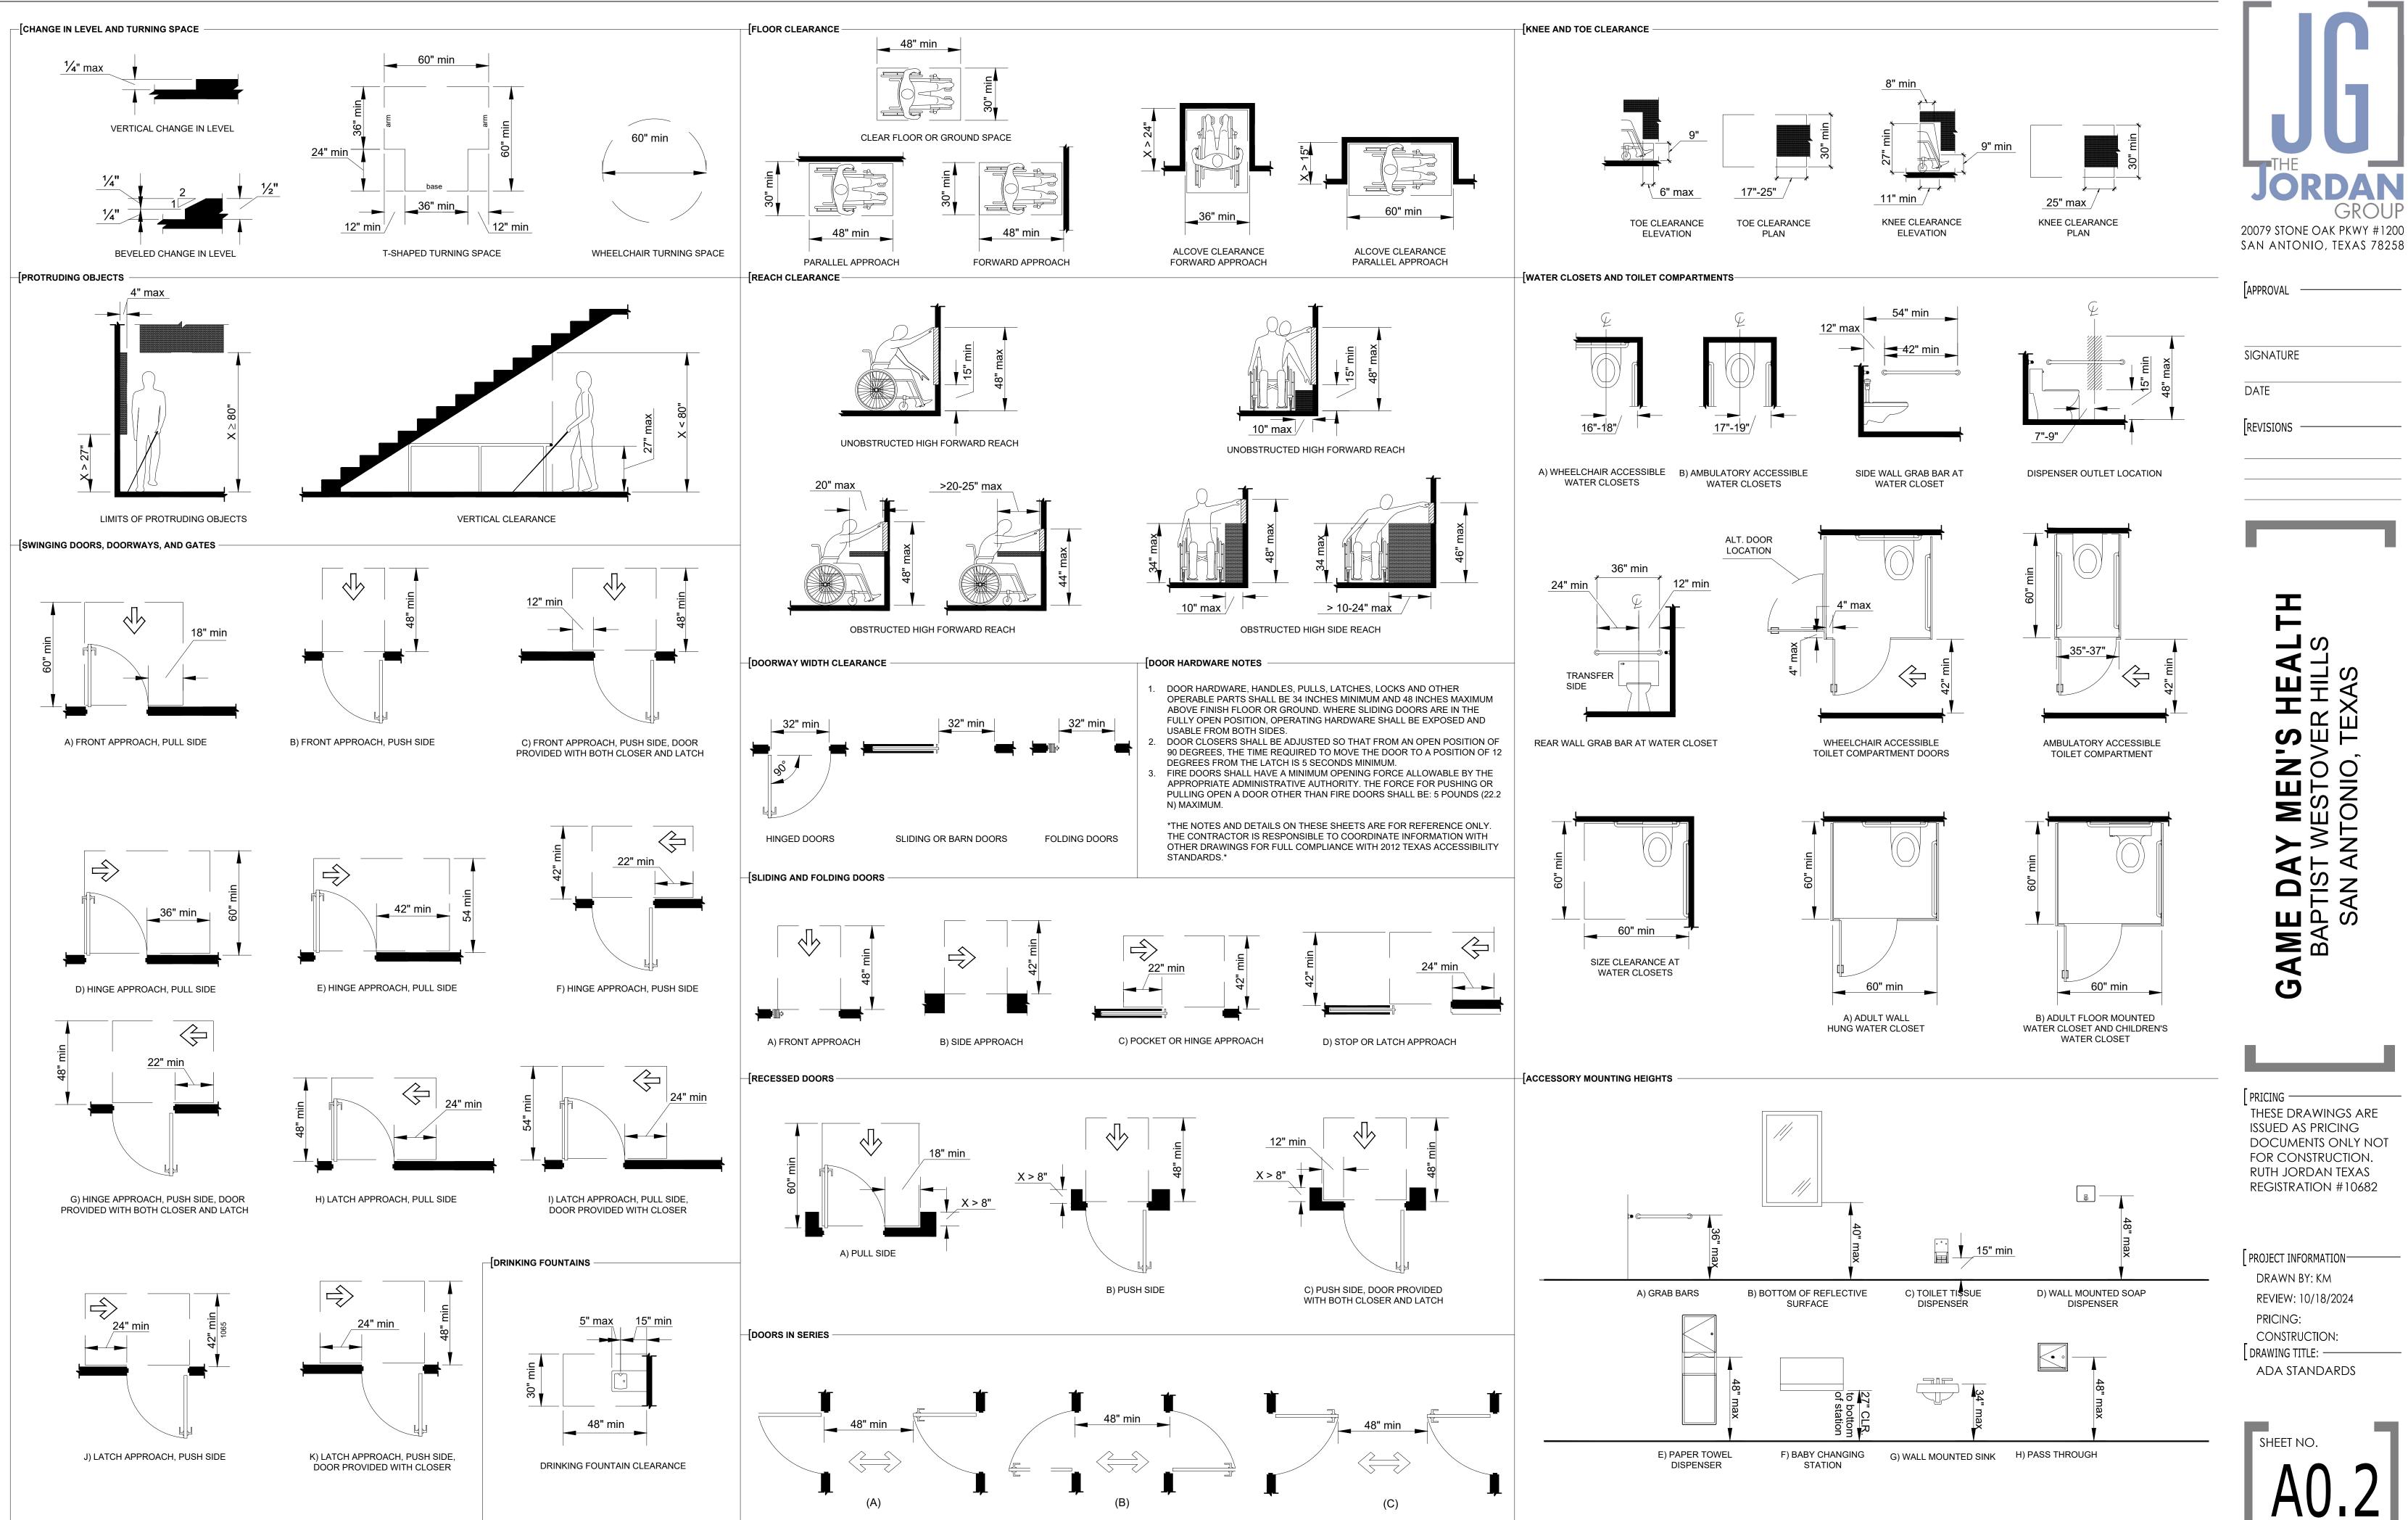

20079 STONE OAK PKWY #1200


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PROJECT INFORMATION

DRAWN BY: KM

REVIEW: 10/18/2024 PRICING: CONSTRUCTION:

DRAWING TITLE: — ADA STANDARDS

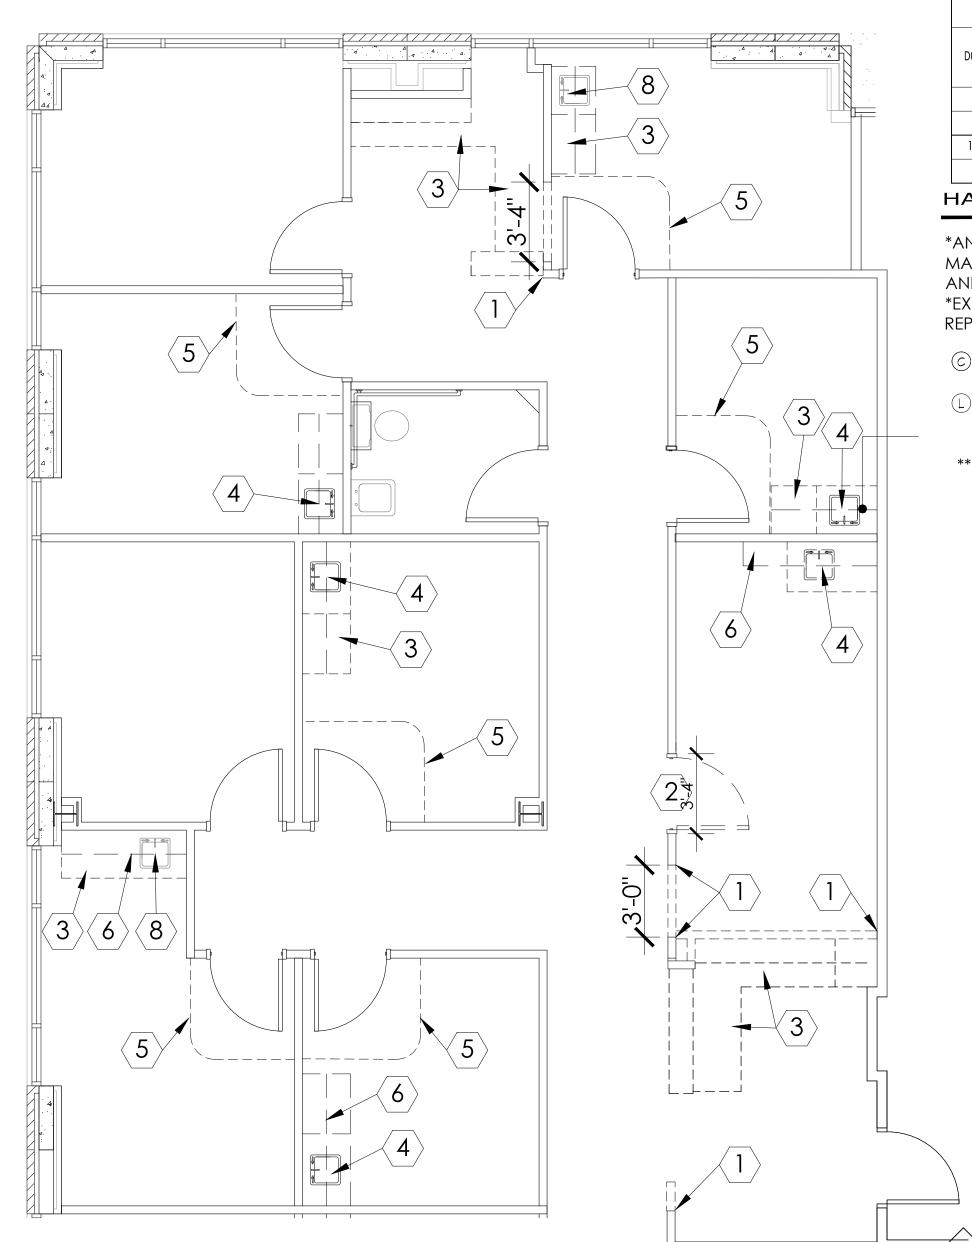

#### DOOR SCHEDULE DOOR # WIDTH DOOR FINISH FRAME FINISH HEIGHT THICKNESS DOOR HARDWARE RACO 3'-0" | 7'-10" | 1-3/4" | S.C. WOOD C,L CLR. ANODIZED 102 C,P RACO CLR. ANODIZED 3'-0" 7'-10" 1-3/4" S.C. WOOD CLR. ANODIZED A 3'-0" 7'-10" 1-3/4" S.C. WOOD RACO 107 B 3'-0" 7'-10" 1-3/4" | N/A N/A RACO CLR. ANODIZED

#### HARDWARE LEGEND

**DOOR LEGEND** 

NEW 3'-0" X 7'-10" X 1

PAINTED GAME DAY

3/4" SOLID CORE

WOOD DOOR, TO

BE SANDED AND

RED, WITH RACO

CLEAR ANODIZED

**ALUMINUM FRAME** 

TO MATCH EXISTING.

EXISTING TO REMAIN.

APPEARANCE.

SERVICE FOR LIKE NEW

\*ANY NEW HARDWARE TO MATCH EXISTING LEVER TYPE HARDWARE, FINISH TO MATCH EXISTING. VERIFY ALL EXISTING CLOSERS ARE IN GOOD WORKING CONDITION AND ENSURE MAX. OPENING FORCE - 5LB/F

\*EXISTING WALL STOPS TO REMAIN, VERIFY IN GOOD WORKING CONDITION. CLEAN, REPAIR OR REPLACE FOR LIKE NEW APPEARANCE. ADD NEW WHERE REQUIRED

© CLOSER (MAX. OPENING FORCE - 5 LB/F)

(L) LOCKSET

\*\*\* ON EGRESS DOORS THAT LOCK: READILY VISIBLE DURABLE SIGN IS TO BE POSTED ON THE EGRESS SIDE ON OR ADJACENT TO THE DOOR STATING: "THIS DOOR TO REMAIN UNLOCKED WHEN THIS SPACE IS OCCUPIED. THE SIGN SHALL BE IN LETTERS 1" HIGH ON A CONTRASTING BACKGROUND.

NEW OR RELOCATED

3'-0" X 7'-10" CASED

OPENING, RACO

CLEAR ANODIZED

MATCH EXISTING.

### **NEW FLOOR PLAN GENERAL NOTES**

- REPAIR OR REPLACE ANY DAMAGED WALL STOPS THROUGHOUT PROTECT ALL EXISTING WINDOWS FROM DAMAGE, DEBRIS & DUST OR OTHERWISE, CLEAN AND SERVICE ALL WINDOWS AFTER CONSTRUCTION IS
- EXISTING WINDOW SILLS TO REMAIN, CLEAN FOR LIKE NEW APPEARANCE.

REPAIR AND PATCH AS REQUIRED. PROVIDE FOR NEW PAINT AS SCHEDULED.

- PROVIDE AND INSTALL NEW ADA COMPLIANT RESTROOM SIGNAGE AS
- PROVIDE FOR DIFFERENCES IN WALL THICKNESS THAT ARE UNFORESEEN DUE TO ENCLOSED STRUCTURE
- EXISTING WINDOW BLINDS TO REMAIN THROUGHOUT. PROTECT DURING CONSTRUCTION FROM DUST, DEBRIS OR OTHERWISE. PROVIDE TO REPLACE and/or repair any damaged units, missing slats, wands or broken STRINGS. INSPECT EACH UNIT INDIVIDUALLY. WHERE NEW WALLS REQUIRE SPLIT OF EXISTING BLINDS, PROVIDE NEW UNITS ACCORDINGLY.
- PROVIDE FOR CONTROL JOINTS AT ALL GWB LOCATIONS IN EXCESS LENGTH OF 30'. COORDINATE JOINT INSTALLATION LOCATIONS WITH DESIGNER. FOLLOW ALL ASTM STANDARDS AND GUIDELINES FOR GYPSUM WALL BOARD APPLICATIONS AND INSTALLATIONS.
- BUILDING MANAGEMENT / OWNER TO PROVIDE PERMANENT SUITE NUMBER SIGANGE PRIOR TO BUILDING FINAL INSPECTION.

#### NEW FLOOR PLAN KEYED NOTES

- (T) NEW DEMISING WALL TO EXTEND TO DECK, EXTEND EXISTING WALL TO MATCH NEW DEMISING WALL.
- (2) EXISTING G.W.B. CLADDING AT COLUMN TO REMAIN, PREPARE SURFACE FOR NEW FINISHES AS SCHEDULED.
- 3 ALIGN NEW WALL WITH EXISTING WALL, MATCH CONSTRUCTION STYLE, WIDTH AND HEIGHT WITH EXISTING.
- PROVIDE NON COMBUSTIBLE IN-WALL WD BLK'G AS REQ. FOR TENANT PROVIDED TV AND BRACKET. INSTALLATION BY G.C. COORDINATE WITH TENANT.
- (5) PROVIDE AND INSTALL 1/4" COPPER WATER LINE & SHUT OFF VALVE FOR CONNECTION TO TENANT PROVIDED AND INSTALLED REFRIGERATOR.
- NEW 24" D PLASTIC LAMINATE COUNTER TOP AND BASE CABINETS WITH 13" D WALL CABINETS, FULL FLUSH OVERLAY CONSTRUCTION, MELAMINE LINED INTERIORS AND 3.5" WIRE PULLS, PROVIDE FOR REMOVABLE ADA PANEL AT SINK AND 4"H BACKSPLASH.
- $\langle 7 \rangle$  NEW 24" D PLASTIC LAMINATE COUNTER TOP.

STG.

- (8) EXISTING DOOR TO BE SANDED AND PAINTED GAME DAY RED.
- (9) EXISTING PLUMBING FIXTURE TO BE REINSTALLED WITHIN NEW MILLWORK, PROTECT DURING CONSTRUCTION, VERIFY IN GOOD WORKING CONDITION, CLEAN AND SERVICE FOR LIKE NEW APPEARANCE. FIXTURE TO BE CONNECTED TO RELOCATED HOT WATER HEATER.
- (10) IN LIEU OF EXISTING MILLWORK, NEW MILLWORK TO MACH GAME DAY STANDARD COLORS, REMOVE EXISTING PLUMBING, RE: ELEVATION. PRICE AS ALTERNATE #2.
- $\langle \Pi 
  angle$  Wall to be sanded and primed to receive Wallcovering, must cure for ONE WEEK PRIOR TO MURAL INSTALLATION. MURAL TO BE PROVIDED AND INSTALLED BY TENANT. CONTACT TENANT AS SOON AS WALL IS PRIMED SO VWC INSTALLATION CAN BE COORDINATED.

EXAM 1

104A

WAITING

102

 $\langle 3 \rangle$ 

# EXISTING PARTITION TO REMAIN = = = EXISTING PARTITION TO BE REMOVED NEW TYPICAL WALL PARTITION, 2/A0.1 NEW DEMISING WALL PARTITION, 1/A0.1 CONVERT TO DEMISING WALL PARTITION LEGEND

# PATH OF TRAVEL

PARTITION TYPES

TRAVEL DISTANCE

A=71'-10"

## OCCUPANT LOAD SCHEDULE

ON FILM FOR SAND						
BLASTED APPEARANCE	ROOM #	ROOM NAME	AREA	LOAD FACTOR	OCCUPANT LOAD	NO. OF EXITS REQ.
INTERIOR SIDE TO BE						PER ROOM
SANDED AND PAINTED	101	RECEPTION	152	150	2	1
GAME DAY RED,	102	WAITING	145	15	10	1
EXTERIOR SIDE TO  MATCH BUILDING  STANDARDS. RACO  CLEAR ANODIZED  108	104A	EXAM 1	89	150	1	1
	105	LAB	109	150	1	1
	108	OFFICE 1	121	150	1	1
ALUMINUM FRAME TO	109	BREAK	121	150	1	1
MATCH EXISTING.	112	EXAM 2	114	150	1	1
	113	OFFICE 2	119	150	1	1
	114	BLOOD DRAW	136	150	1	1
	115	EXAM 3	101	150	1	1
TOTAL:					20	

SCALE: 1/4" = 1'-0"

4'-0'' BREAK  $\square ALL$ 109 10/3 EXAM 2 **OFFICE** 112 113 HALL 102 111 (6) (9) 5'-0'' **RECEPTION BLOOD DRAW** EXAM 3 101 114 115 FLOOR PLAN



**SIGNATURE** 

REVISIONS

 $\triangleleft$ 4 1 ШФ

104B

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DOCUMENTS ONLY NOT FOR CONSTRUCTION. RUTH JORDAN TEXAS REGISTRATION #10682

PROJECT INFORMATION—

DRAWN BY: KM REVIEW: 10/18/2024 PRICING:

CONSTRUCTION: DRAWING TITLE: -DEMO FLOOR PLAN NEW FLOOR PLAN LIFE SAFETY

FINISH PLAN

SHEET NO.

SHEET 4 OF 6

#### SCALE: 1/4" = 1'-0" **DEMO PLAN KEYED NOTES**

 $\langle \overline{1} 
angle$  DEMO WALL BACK AS INDICATED, PATCH AT POINT OF REMOVAL

(2) REMOVE EXISTING DOOR AND FRAME, STOCKPILE FOR REUSE WITH NEW CONSTRUCTION, IF APPLICABLE. CLEAN, SERVICE AND REPAIR FOR LIKE NEW APPEARANCE. INFILL EXISTING OPENING AT REMOVED DOOR, PREPARE TO RECEIVE NEW FINISHES. MATCH CONSTRUCTION STYLE, WIDTH AND HEIGHT WITH EXISTING.

(3) EXISTING MILLWORK TO BE REMOVED.

DEMO FLOOR PLAN

- REMOVE EXISTING PLUMBING FIXTURE, SALVAGE AND STOCKPILE FOR REUSE. CAP WATER LINES BACK AT SOURCE OR POINT OF REUSE.
- (5) REMOVE EXISTING CEILING HUNG PRIVACY TRACK AND CURTAINS, PATCH OR REPLACE CEILING TILES AS REQUIRED AT POINT OF TRACK REMOVAL.
- (6) REMOVE EXISTING WALL CABINETS, PATCH AND REPAIR WALL TO RECEIVE NEW FINISHES AS SPECIFIED.
- (7) EXISTING MILLWORK TO REMAIN. PROTECT DURING CONSTRUCTION, CLEAN, REPAIR, & SERVICE AS REQUIRED FOR 'LIKE NEW' APPEARANCE.
- (8) SALVAGE PLUMBING FIXTURE FOR REUSE IN NEW CONSTRUCTION. REINSTALL WITH NEW SPECIFIC MILLWORK.

#### FINISH SCHEDULE GENERAL NOTES

1. ALL FINISHES COMPLY WITH IBC 2021 SECTION 803.

#### **ROOM FINISH LEGEND**

**FLOORING** 

LUXURY VINYL TILE, BY SHAW, 0454V TERRAIN II, COLOR: TBD BASE

RUBBER COVE BASE, BY TBD, COLOR: TBD

WALLS WALLS ARE TO RECEIVE 1 COAT OF PRIMER AND 2 COATS OF INTERIOR LATEX ENAMEL, EGGSHELL FINISH. TEXTURE TO BE ROLL ON ORANGE PEEL OR TO MATCH EXISTING ADJACENT WALLS, COORDINATE WITH TENANT. PROVIDE SAMPLES OF ALL PAINT COLORS ON SITE FOR DESIGNERS APPROVAL A MINIMUM OF 1 WEEK PRIOR TO SCHEDULED PAINTING. DESIGNER RESERVES THE RIGHT TO MODIFY PAINT COLORS AT THAT TIME. DO NOT TINT FINAL PAINT UNTIL DESIGNER HAS PROVIDED FINAL APPROVAL. PRICE TO PROVIDE ONE ACCENT COLOR AT EACH ROOM.

PAINT BY BEHR, IMPERIAL GREY, PPU26-02 (OVERALL) PT-2 PAINT BY TBD, COLOR TBD (ACCENT) PANTONE 485C, INTERIOR DOOR COLOR

PT-4 PAINT BY TBD, COLOR TBD (G.W.B. CEILINGS) PAINT BY TBD, COLOR TBD (HOLLOW METAL WINDOW &

DOOR FRAMES) PROFESSIONAL VINYL WALL COVERING PRIMER

#### MILLWORK

PL-3

PL-1 PLASTIC LAMINATE, BY TBD (RECEPTION WORKSURFACE) PL-2 PLASTIC LAMINATE, BY TBD (GENERAL COUNTER / WORKSURFACE)

PLASTIC LAMINATE, TBD (GENERAL UPPER/WALL BASE)

ROLLER SHADE BY SEIRRA WINDOW FASHION, 5% OPENESS, INSIDE MOUNT, VALANCE TO MATCH WINDOW FRAME COLOR, SHADE COLOR TO BE SELECTED. PRICE AS ALTERNATE

#### FLOOR ROOM # ROOM NAME NOTES N | E | S | W 101 RECEPTION RB-1 | PT-1 | PT-3 | PT-1/PR | PT-1/PR PT-1 102 WAITING 103 HALL 104A EXAM 1 104B I.T. 105 LAB 106 HALL 107 STORAGE 108 OFFICE 109 BREAK 110 RR 111 | HALL 112 EXAM 2 113 OFFICE 114 BLOOD DRAW 115 EXAM 3 **\*** | **\*** | **\*** | **\*** | **\***

ROOM FINISH SCHEDULE

\*\* ACCENT PAINT LOCATIONS & FLOORING PATTERNS TO BE DETERMINED. \*\*\* ALLOW FOR ONE ACCENT WALL PER ROOM.

#### FLOOR PATTERN LEGEND

**EXISTING SOLID CORE** 


FULL HEIGHT 1" THICK


TEMPERED GLASS


ALUMINUM FRAME TO INSERT WITH APPLIED

WOOD DOOR CUT IN A

LVT: LUXURY VINYL TILE

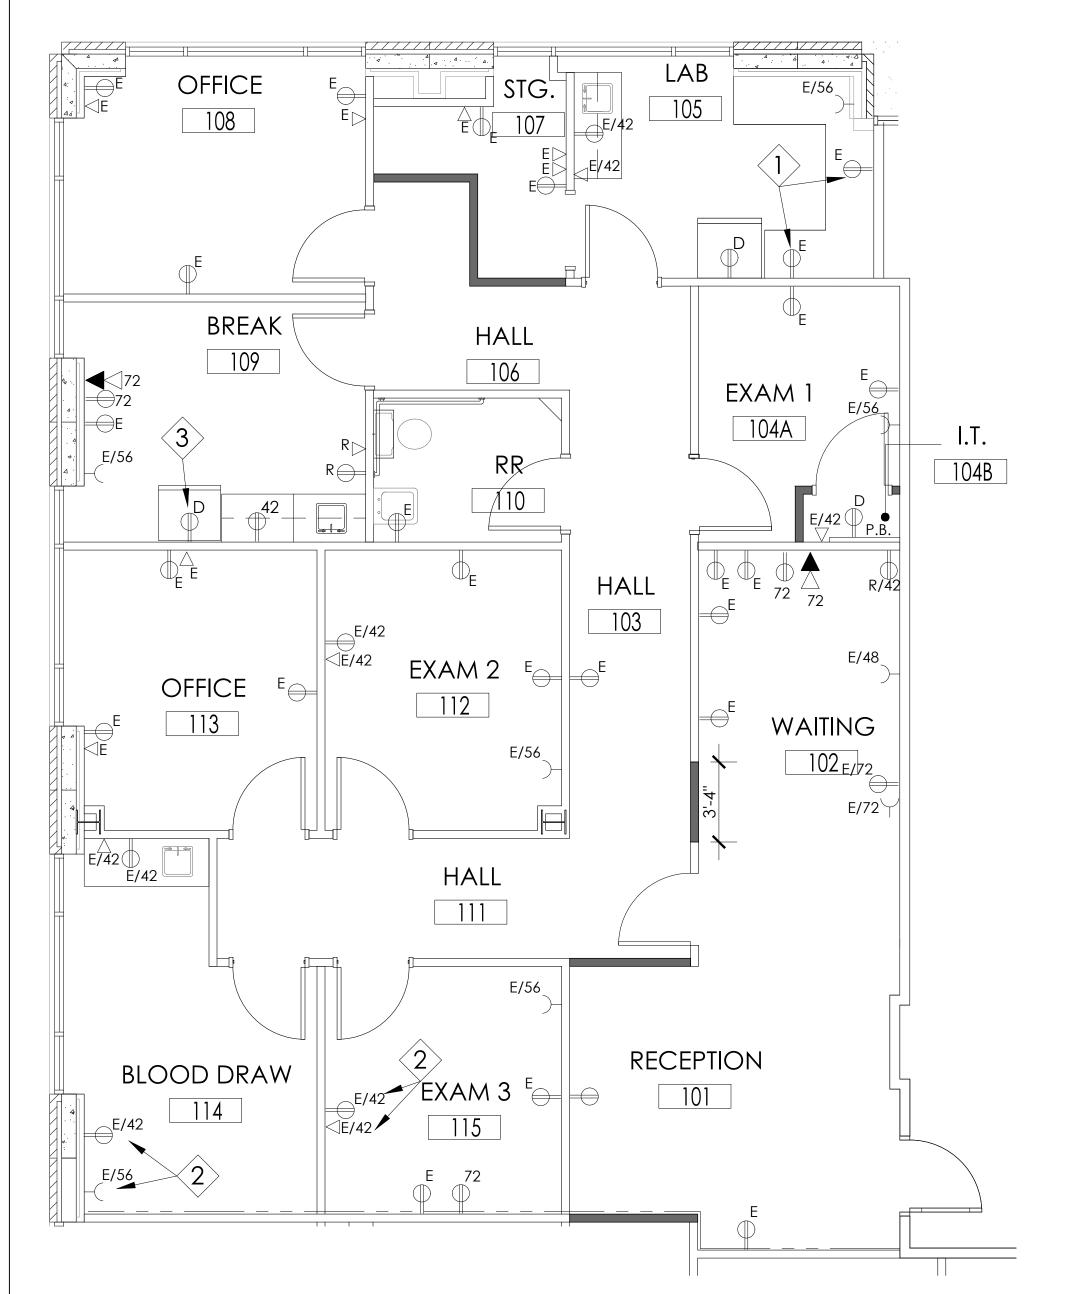

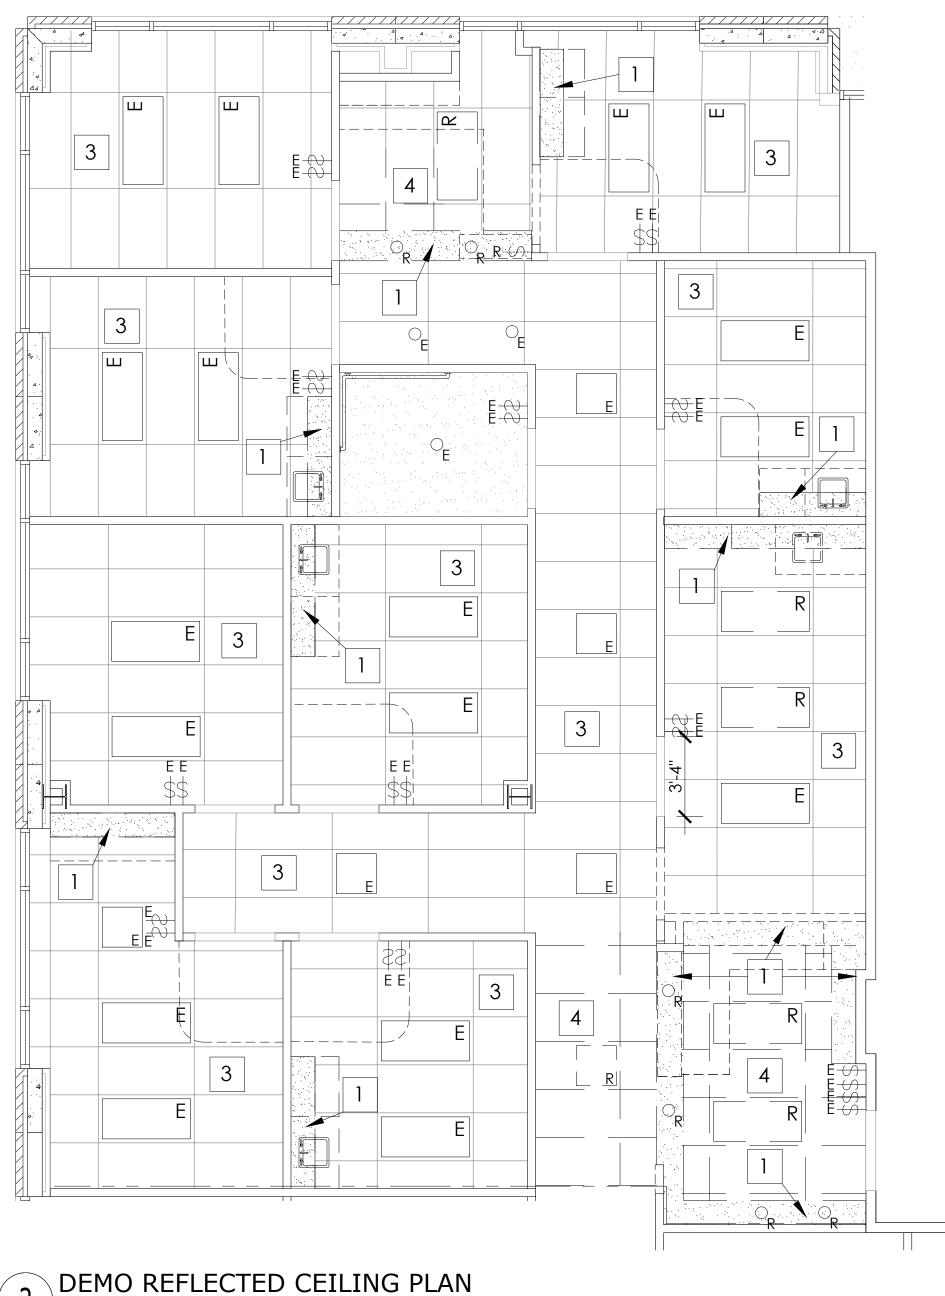

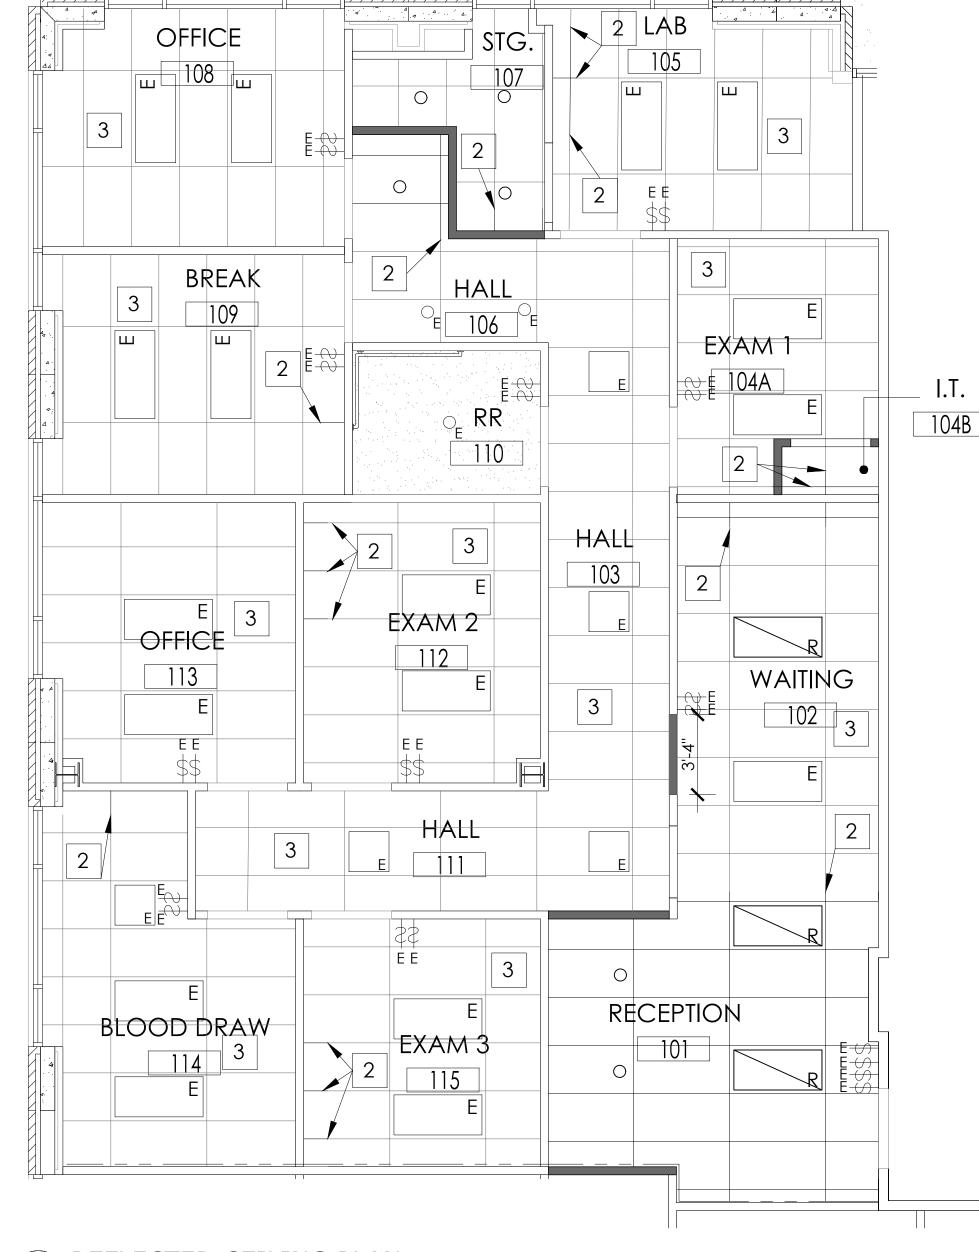

# REFLECTED CEILING PLAN SCALE: 1/4" = 1'-0"

# **POWER GENERAL NOTES**

**POWER PLAN** 

SCALE: 1/4" = 1'-0"

- 1. AT ALL EXISTING OUTLETS AND SWITCHES CLEAN, REPAIR, & SERVICE AS REQUIRED FOR 'LIKE NEW' APPEARANCE.
- 2. ANY NEW COVER PLATES TO BE WHITE TO MATCH EXISTING. 3. INSTALL GFCI OUTLETS AT ANY PLUG LOCATIONS NEAR WATER SOURCES.
- 4. MEP TO VERIFY EXACT LOCATIONS OF ALL POWER/DATA OUTLETS. REFER TO MEP FOR
- SPECIFICATION U.O.N. ON INTERIOR'S DRAWINGS.
- WHERE ELECTRICAL OUTLETS AND PHONE DATA OUTLETS ARE INDICATED TO BE ADJACENT TO EACH OTHER. THE MAXIMUM ALLOWABLE DIMENSION BETWEEN COVERPLATES SHALL BE 3". UTILIZE BRIDGES BETWEEN STUDS AS REQUIRED TO ACHIEVE REQUIRED SEPARATION DISTANCE AND LOCATIONS INDICATED ON PLAN.
- PROVIDE GROMMET HOLES AS NECESSARY COLOR TO BE SELECTED, COORDINATE EXACT LOCATION WITH TENANT.
- 7. OWNER PROVIDED AND INSTALL TV MONITORS NOT TO EXCEED 4" IN DEPTH (INCLUDING MOUNTING EQUIPMENT)
- 8. PROVIDE NEW FIRE STROBE AT ALL EXAM ROOMS AS REQUIRED. 9. EXISTING OUTLETS LOCATED AT 18"AFF UNLESS OTHERWISE NOTED.
- 10. MOUNT OUTLETS ABOVE COUNTER TOPS HORIZONTALLY.

#### POWER LEGEND NOTES

- $\uparrow$  Raise existing outlet to 44" Aff. Patch & Repair Wall at Point of Outlet REMOVAL. TAPE, FLOAT, TEXTURE, & PAINT AS SPECIFIED.
- (2) LOWER EXISTING OUTLET TO 18" AFF. PATCH & REPAIR WALL AT POINT OF OUTLET REMOVAL. TAPE, FLOAT, TEXTURE, & PAINT AS SPECIFIED.
- 3 EXISTING OUTLET TO BE CONVERTED TO DEDICATED.

### POWER LEGEND

- **EXISTING DUPLEX TO REMAIN**
- EXISTING PHONE/DATA OUTLET TO REMAIN
- EXISTING DUPLEX TO REMAIN. # INDICATES MOUNTED HEIGHT OF OUTLET.

SCALE: 1/4" = 1'-0"

- $R \longrightarrow EXISTING DUPLEX TO BE REMOVED.$
- EXISTING CABLE TO REMAIN.
- NEW DUPLEX OUTLET MOUNTED AT 18" AFF. (U.O.N.)

NEW DEDICATED DUPLEX OUTLET MOUNTED AT 18" AFF. (U.O.N.)

NEW PHONE / DATA OUTLET MOUNTED AT 18" AFF (U.O.N.) PROVIDE 3/4" DIA. CONDUIT, STUB OUT ABOVE CEILING WITH PULL STRING.

### RCP NOTES

- $| \ | \ |$  Existing GWB furr down to be removed.
- 2 NEW 2X4 CEILING TILE AND GRID TO CONTINUE FROM EXISTING GRID @ 8'-11" AFF
- 3 EXISTING CEILING TILE AND GRID TO REMAIN, REPAIR OR REPLACE ANY DAMAGED OR STAINED CEILING TILES @ 8'-11"
- EXISTING CEILING TILE AND GRID TO BE REMOVED & RELOCATED GRID FOR REUSE WITH NEW CONSTRUCTION.

#### RCP LEGEND

NEW 2X4 CEILING TILES AND GRID AS SPECIFIED. EXISTING 2X4 CEILING TILES AND GRID AS SPECIFIED. EXISTING G.W.B. CEILING TO BE PAINTED PT-x. EXISTING G.W.B. CEILING TO BE REMOVED. EXISTING 2X4 CEILING TILE/GRID TO BE REMOVED & RELOCATED  $\mathsf{T} = \mathsf{T}$ EXISTING 2X4 LIGHT FIXTURE TO REMAIN. CLEAN & SERVICE FOR 'LIKE-NEW' APPEARANCE. REPLACE ANY BURNED OUT BULBS. EXISTING 2X2 LIGHT FIXTURE TO REMAIN. CLEAN & SERVICE FOR 'LIKE-NEW' APPEARANCE. REPLACE ANY BURNED OUT BULBS.

EXISTING 6" RECESSED DOWNLIGHT TO BE REMOVED OR RELOCATED.

EXISTING 2X4 LIGHT FIXTURE TO BE REMOVED/RELOCATED.

EXISTING 2X2 LIGHT FIXTURE TO BE REMOVED/RELOCATED.

RELOCATED 2X4 LED LIGHT FIXTURE.

- NEW LED 6" RECESSED DOWNLIGHT.
- EXISTING DUAL WALL SWITCHES TO REMAIN. CLEAN & SERVICE FOR 'LIKE-NEW' APPEARANCE.
- WALL SWITCHES TO BE REMOVED. PATCH & REPAIR WALL AT POINT OF REMOVAL. TAPE, FLOAT, TEXTURE, & PAINT AS SPECIFIED.

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SAN ANTONIO, TEXAS 78258

**SIGNATURE** 

DATE

PRICING


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PROJECT INFORMATION————


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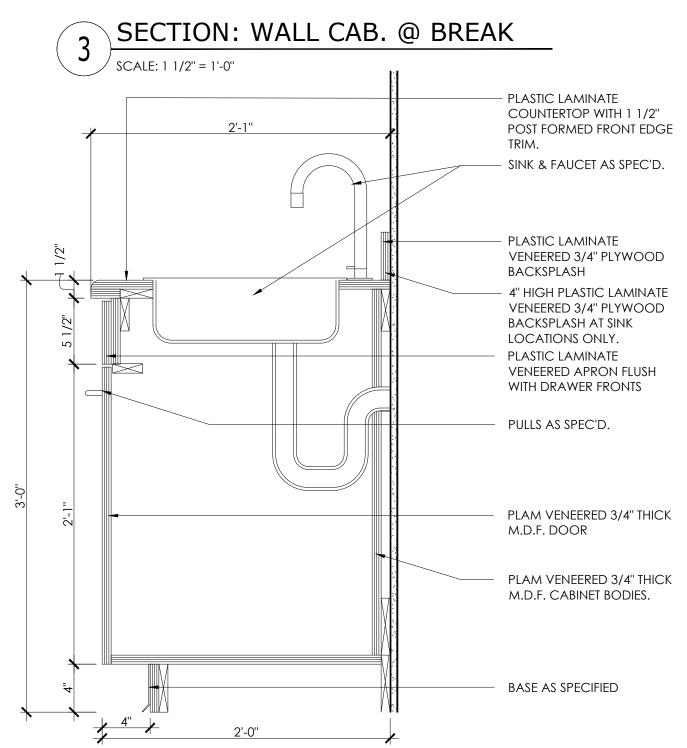
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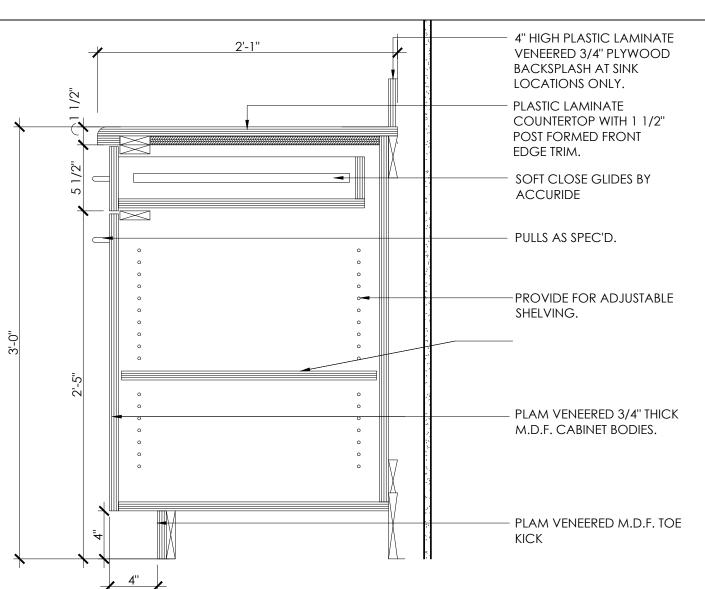
> SHEET NO. SHEET 5 OF 6



## SECTION: BASE CAB. @ BREAK SCALE: 1 1/2" = 1'-0"




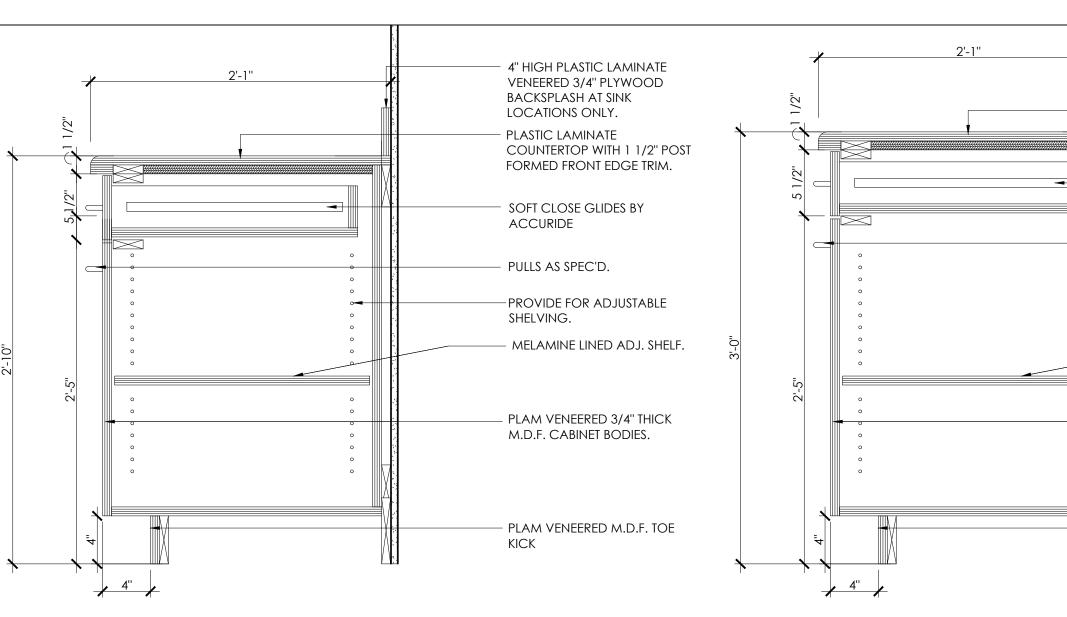

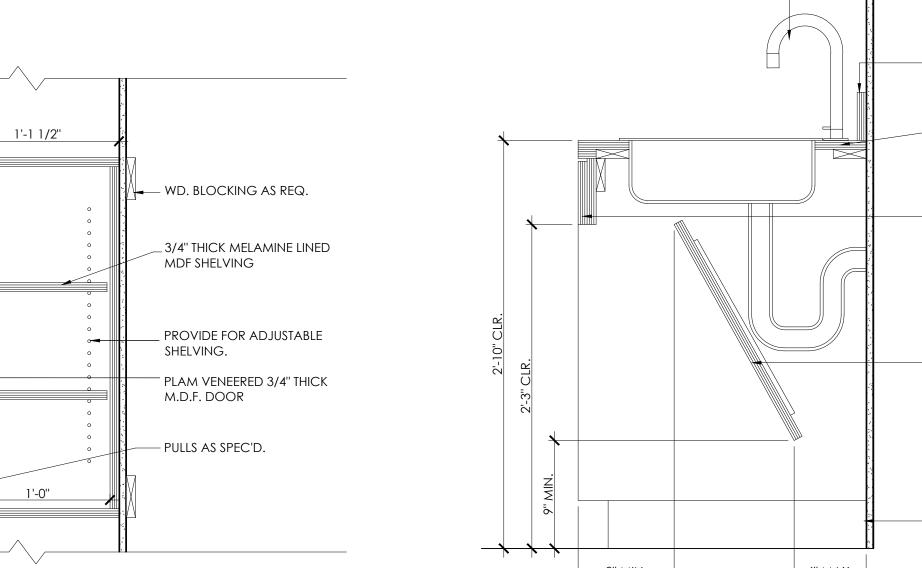


SECTION: BASE CAB. @ LAB

SCALE: 1 1/2" = 1'-0"

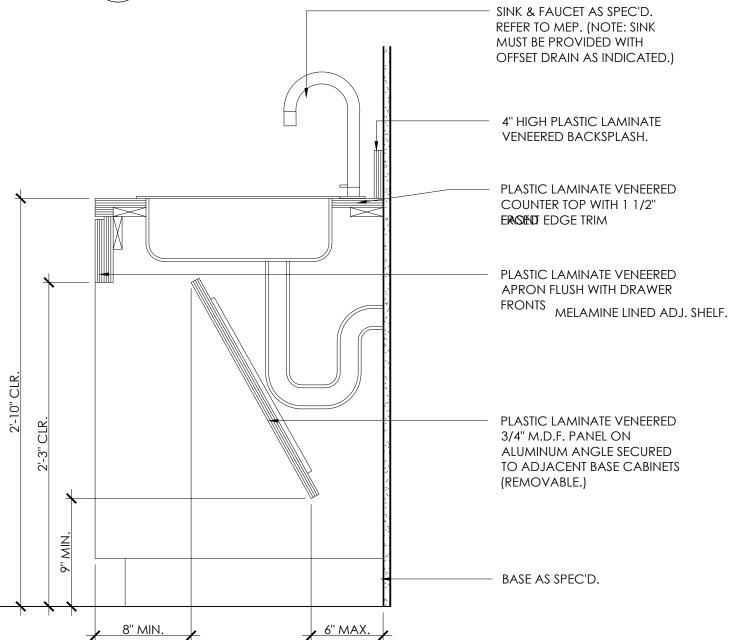


SECTION: ADA SINK @ BREAK


SCALE: 1 1/2" = 1'-0"

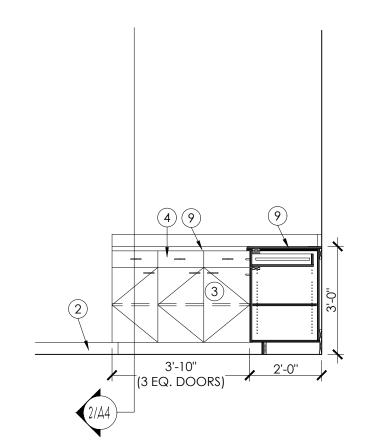

ELEV: (N) 105 LAB SCALE: 3/8" = 1'-0"

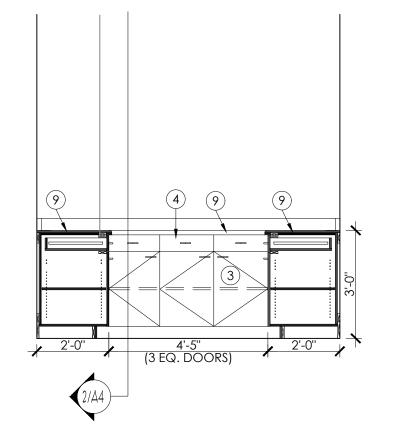


ELEV: (E) 105 LAB SCALE: 3/8" = 1'-0"

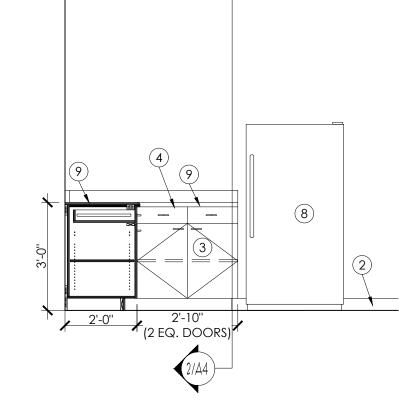


ELEV: (S) 105 LAB

SCALE: 3/8" = 1'-0"

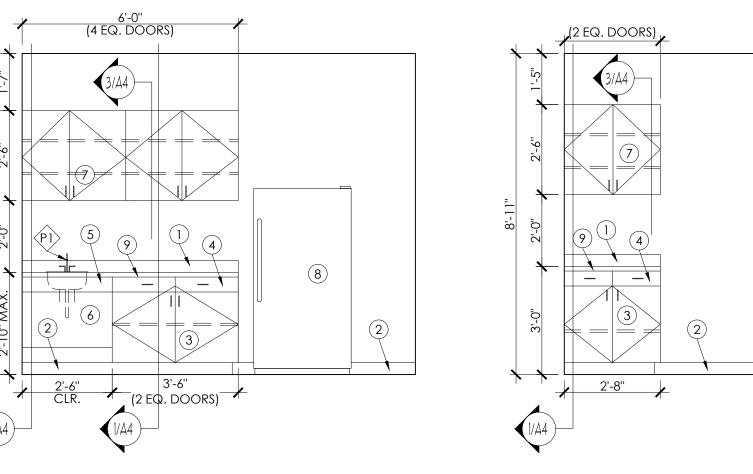


ELEV: (S) 109 BREAK

SCALE: 3/8" = 1'-0"

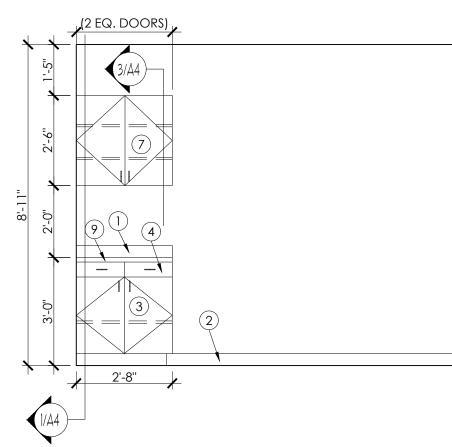

SCALE: 3/8" = 1'-0"

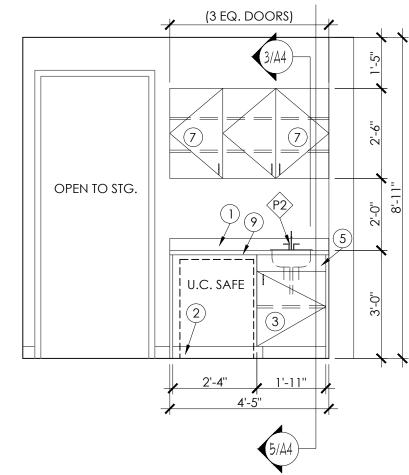

**ELEV: (W) 105 LAB** SCALE: 3/8" = 1'-0"

## **ELEVATION KEYED NOTES**

- (1) 4" HIGH PLASTIC LAMINATE VENEERED BACK SPLASH.
- (2) BASE AS SCHEDULED.
- (3) PLASTIC LAMINATE VENEERED BASE CABINETS, 24" DEEP (U.N.O). PROVIDE FULL FLUSH OVERLAY CONSTRUCTION, CONCEALED HINGES MELAMINE LINER INTERIORS, ADJUSTABLE SHELVES AS INDICATED, AND 3 1/2" WIRE PULLS TO BE SELECTED.
- (4) PLASTIC LAMINATE VENEERED DRAWERS, FULL FLUSH OVERLAY CONSTRUCTION, MELAMINE LINERS, ACUGLIDES AND 3.5" BRUSHED CHROME WIRE PULLS.
- (5) PLASTIC LAMINATE VENEERED APRON, FLUSH WITH DRAWER FRONTS.
- (6) PLASTIC LAMINATE VENEERED ANGLED ADA PANEL. RE: DETAILS X/AX.
- 7) PLASTIC LAMINATE VENEERED WALL CABINETS, 13"DEEP. PROVIDE FULL FLUSH OVERLAY CONSTRUCTION, CONCEALED HINGES, MELAMINE LINER INTERIORS, ADJUSTABLE SHELVES AS INDICATED, AND 3 1/2"BRUSHED CHROME WIRE PULLS MOUNTED VERTICALLY.
- 8 REFRIGERATOR PROVIDED BY TENANT, INSTALLED BY G.C. COORD. WITH TENANT. PROVIDE 1/4" FLEXIBLE COPPER WATER LINE WITH SHUT-OFF VALVE.
- (9) PLASTIC LAMINATE VENEERED COUNTERTOP WITH 1-1/2" EASED FRONT EDGE TRIM.
- (10) 1-1/2" THICK PLASTIC LAMINATE VENEERED END/SUPPORT PANEL.

#### PLUMBING FIXTURE SCHEDULE

- PI BREAKROOM: ADA COMPLIANT SINGLE BOWL DROP-IN, 21" X 25" X 6", STAINLESS STEEL, WITH GOOSENECK FAUCET WITH WRIST BLADE HANDLES. RE MEP PLANS FOR SPECIFICATION.
- LAB: REUSE EXISTING SINK, CLEAN AND SERVICE FOR LIKE NEW APPEARANCE. VERIFY IN GOOD WORKING CONDITION.

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20079 STONE OAK PKWY #1200

SAN ANTONIO, TEXAS 78258

APPROVAL

SIGNATURE

PROJECT INFORMATION———— DRAWN BY: KM

REVIEW: 10/18/2024 PRICING: CONSTRUCTION:

DRAWING TITLE: — SECTIONS & ELEVATIONS

SHEET NO.

SECTION: SINK @ LAB

SCALE: 1 1/2" = 1'-0"